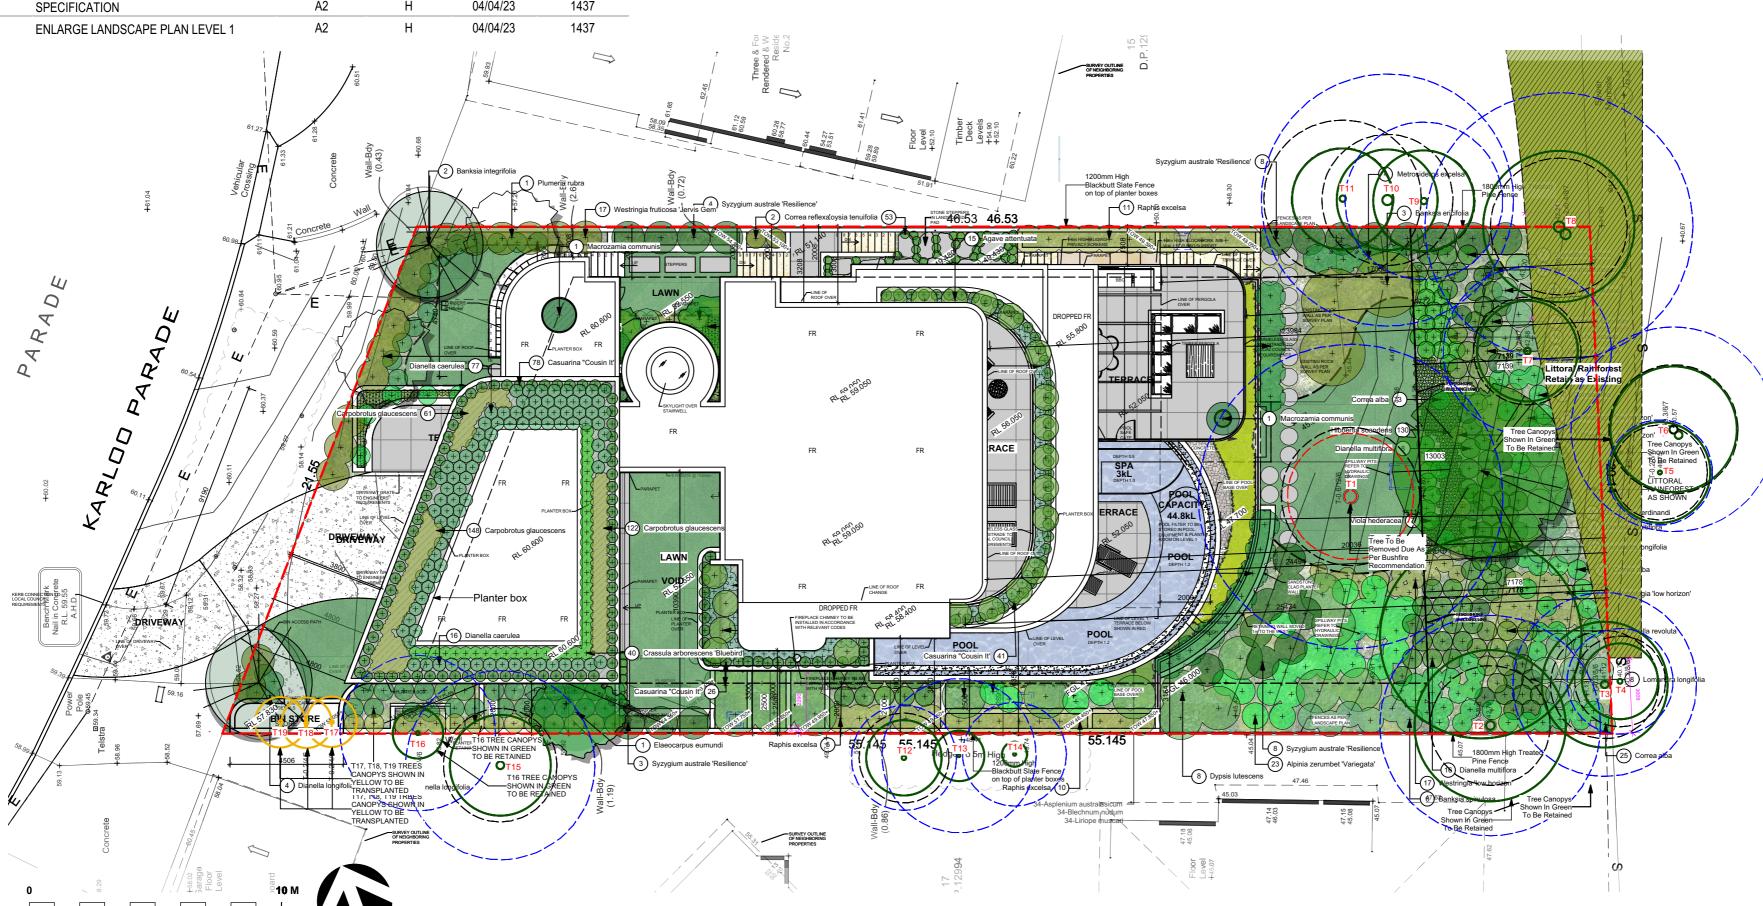
LANDSCAPEDA

27 KARLOO PARADE, NEWPORT, NSW

Drawing List

| Sheet No. | Sheet Name | Sheet Size | Rev. No. | Rev. Date | Project No. |
|-----------|----------------------------------|------------|----------|-----------|-------------|
| L-01 | SITE PLANS | A2 | Н | 04/04/23 | 1437 |
| L-02 | LEVEL 1 LANDSCAPE PLAN | A2 | Н | 04/04/23 | 1437 |
| L-03 | LEVEL 2 LANDSCAPE PLAN | A2 | Н | 04/04/23 | 1437 |
| L-04 | LEVEL 3 LANDSCAPE PLAN | A2 | Н | 04/04/23 | 1437 |
| L-05 | ROOF LANDSCAPE PLAN | A2 | Н | 04/04/23 | 1437 |
| L-06 | PLANTING DETAILS | A2 | Н | 04/04/23 | 1437 |
| L-07 | NOTES | A2 | Н | 04/04/23 | 1437 |
| L-08 | SPECIFICATION | A2 | Н | 04/04/23 | 1437 |
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EXISTING TREE LEGEND

EXISTING TREES TO BE RETAINED EXISTINGTREES TO SRZ (STRUCTURAL TPZ (TREE PROTECTION ZONE) EXISTING PALMS TO BE TRANSPLANTED

LEGEND

PROPOSED POOL / POND PAVED TYPE 2
SELECTED TILE OR PAVER STORMWATER PIT REFER TO HYDRAULIC DRAWINGS

04/04/23 FOR REVIEW ISSUE DATE COMMENT

AMENDMENTS

GENERAL NOTES

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NOTE

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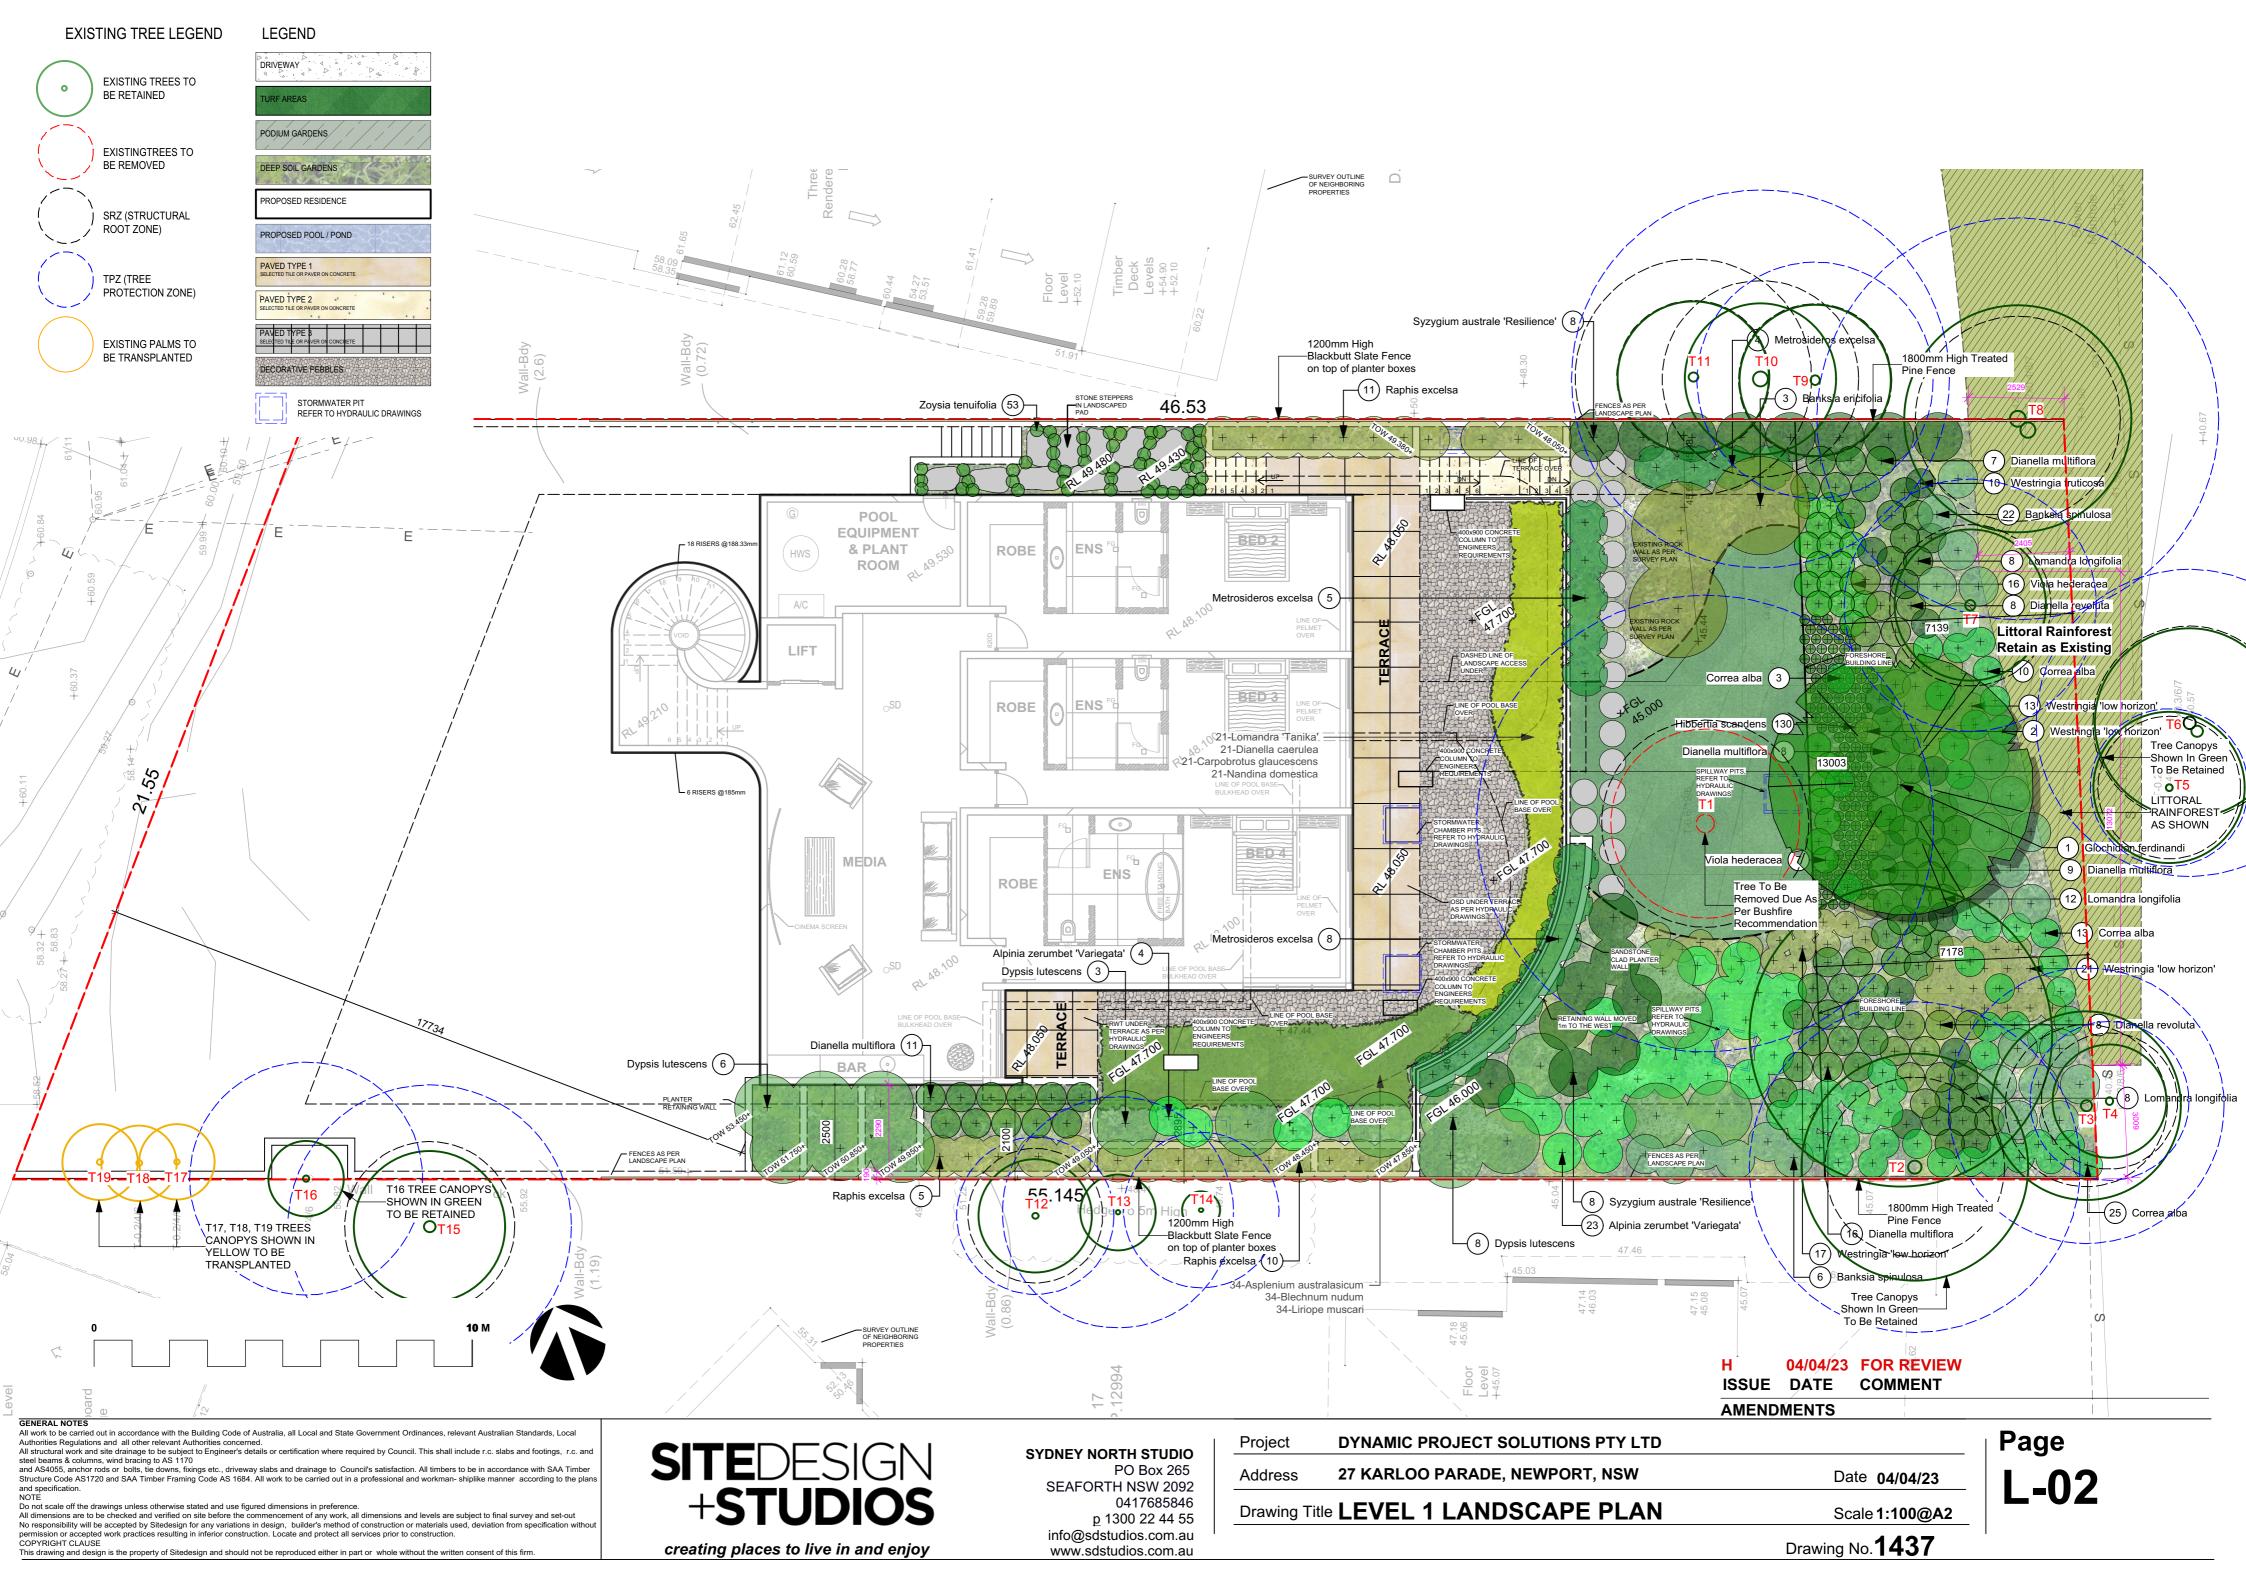
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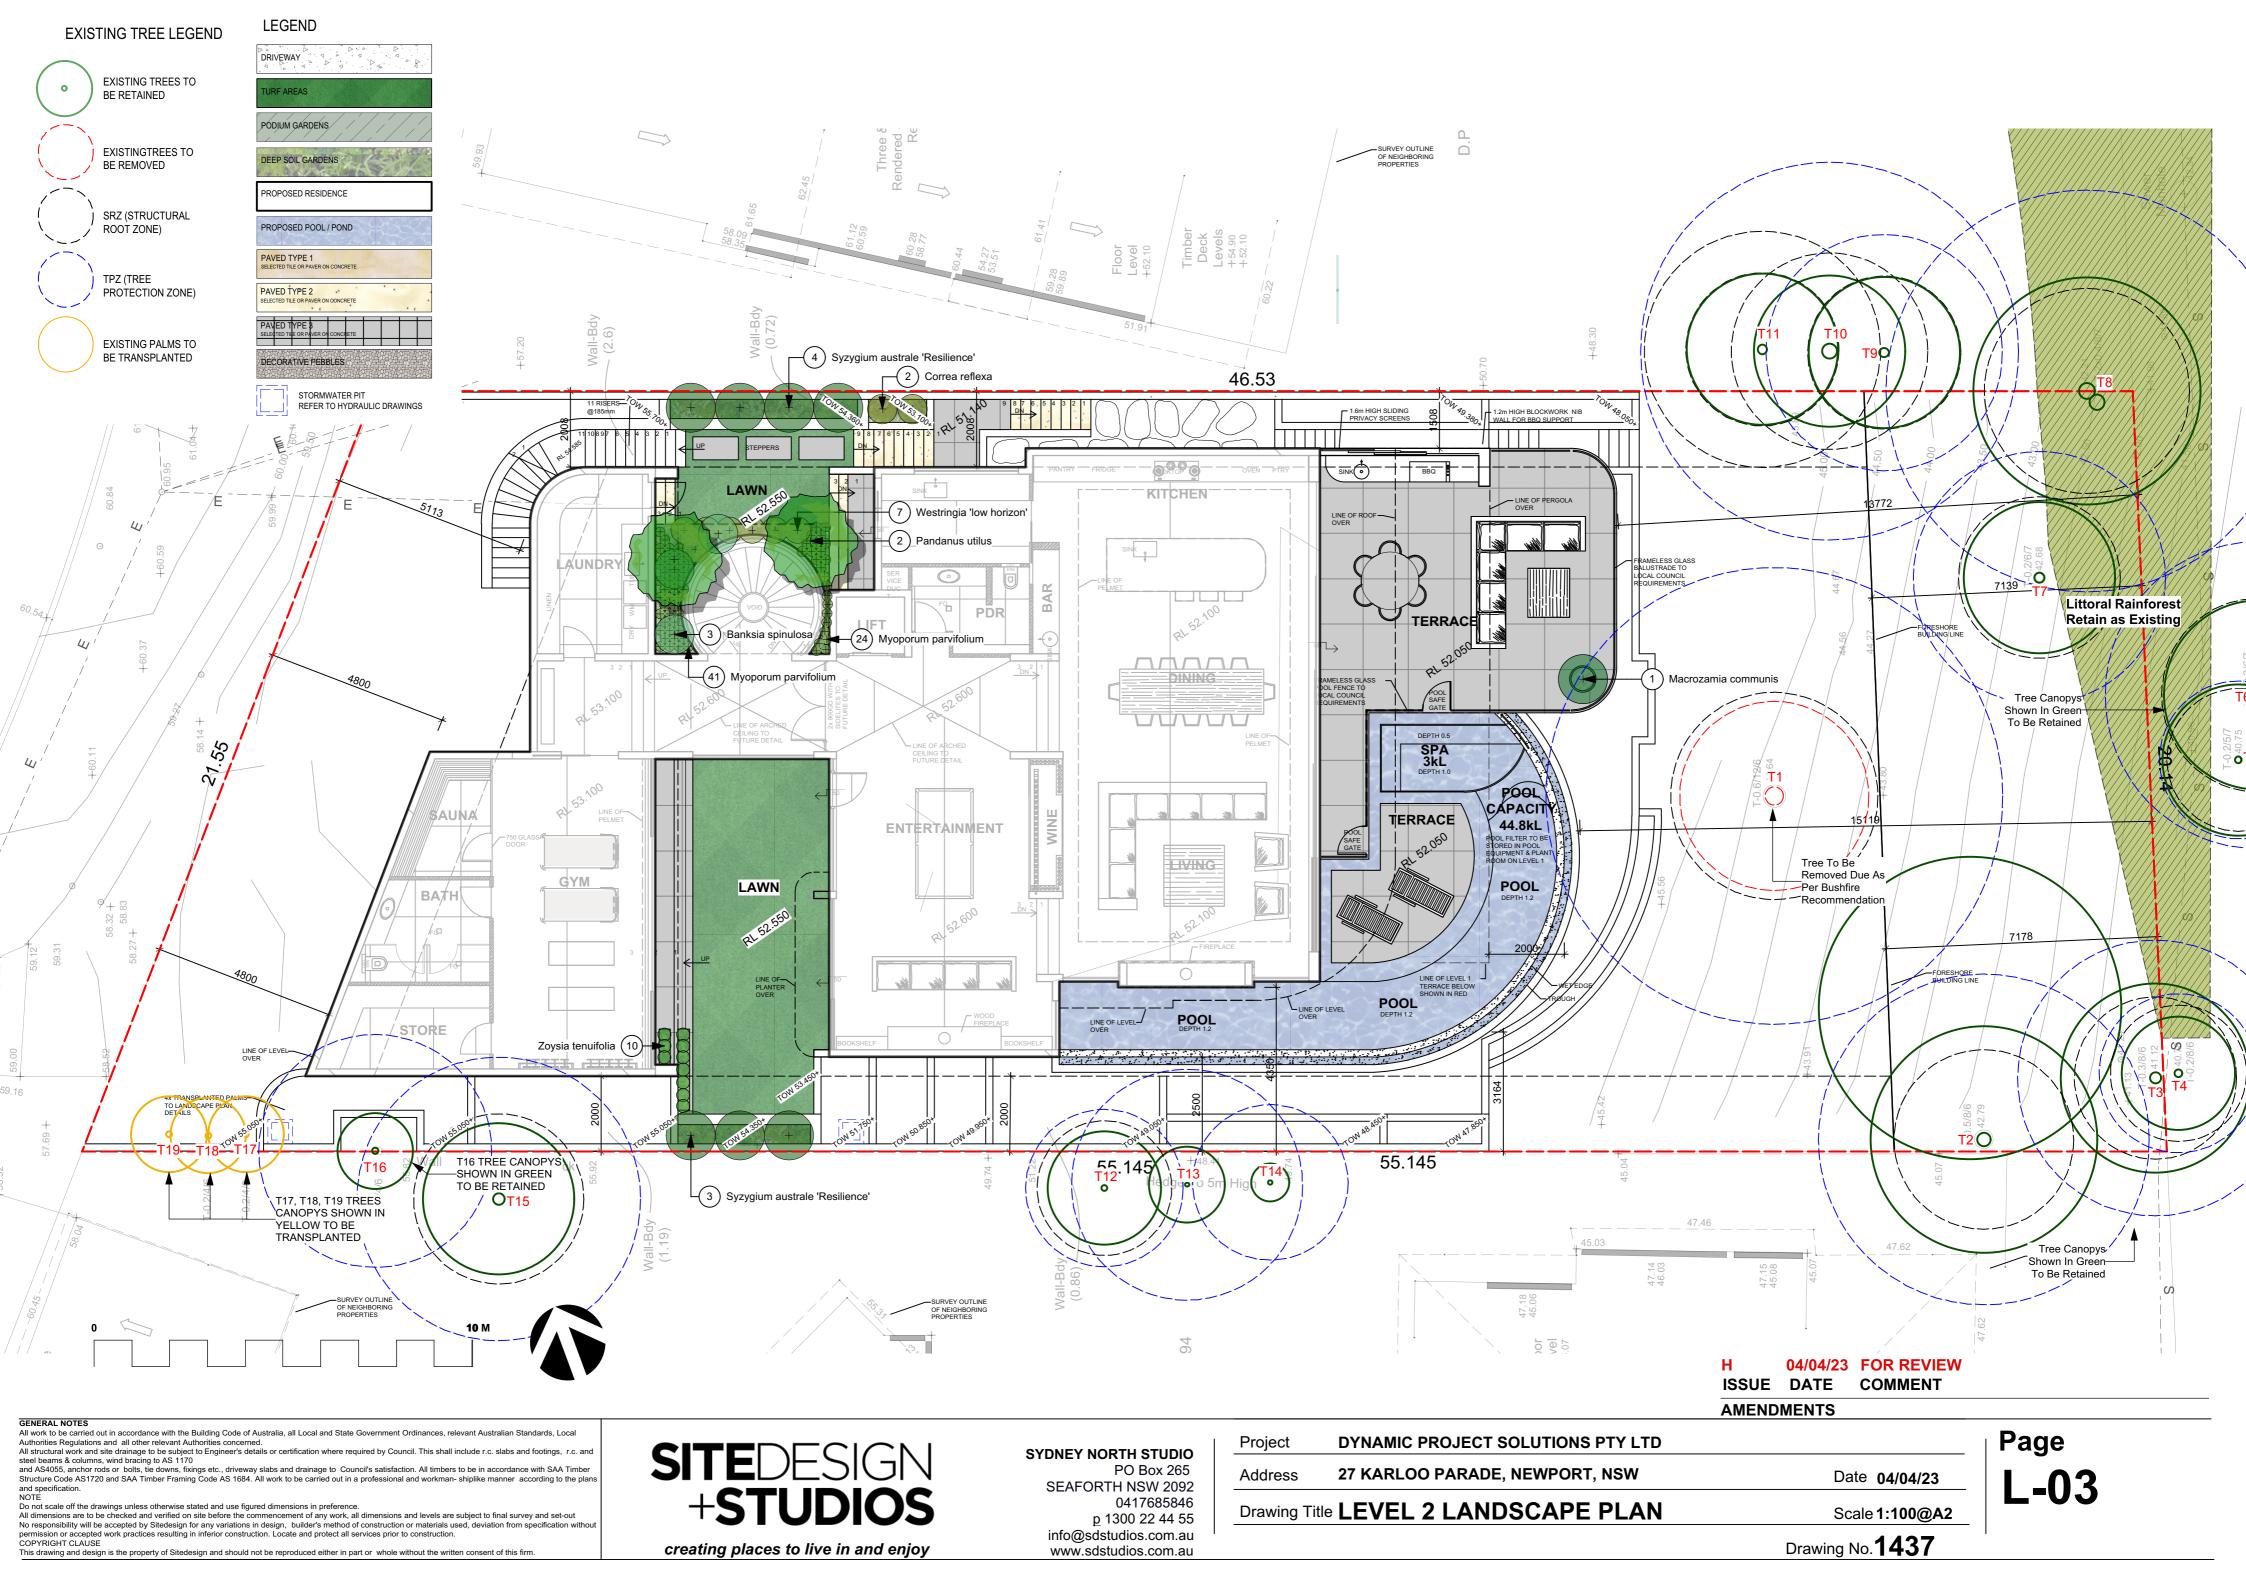
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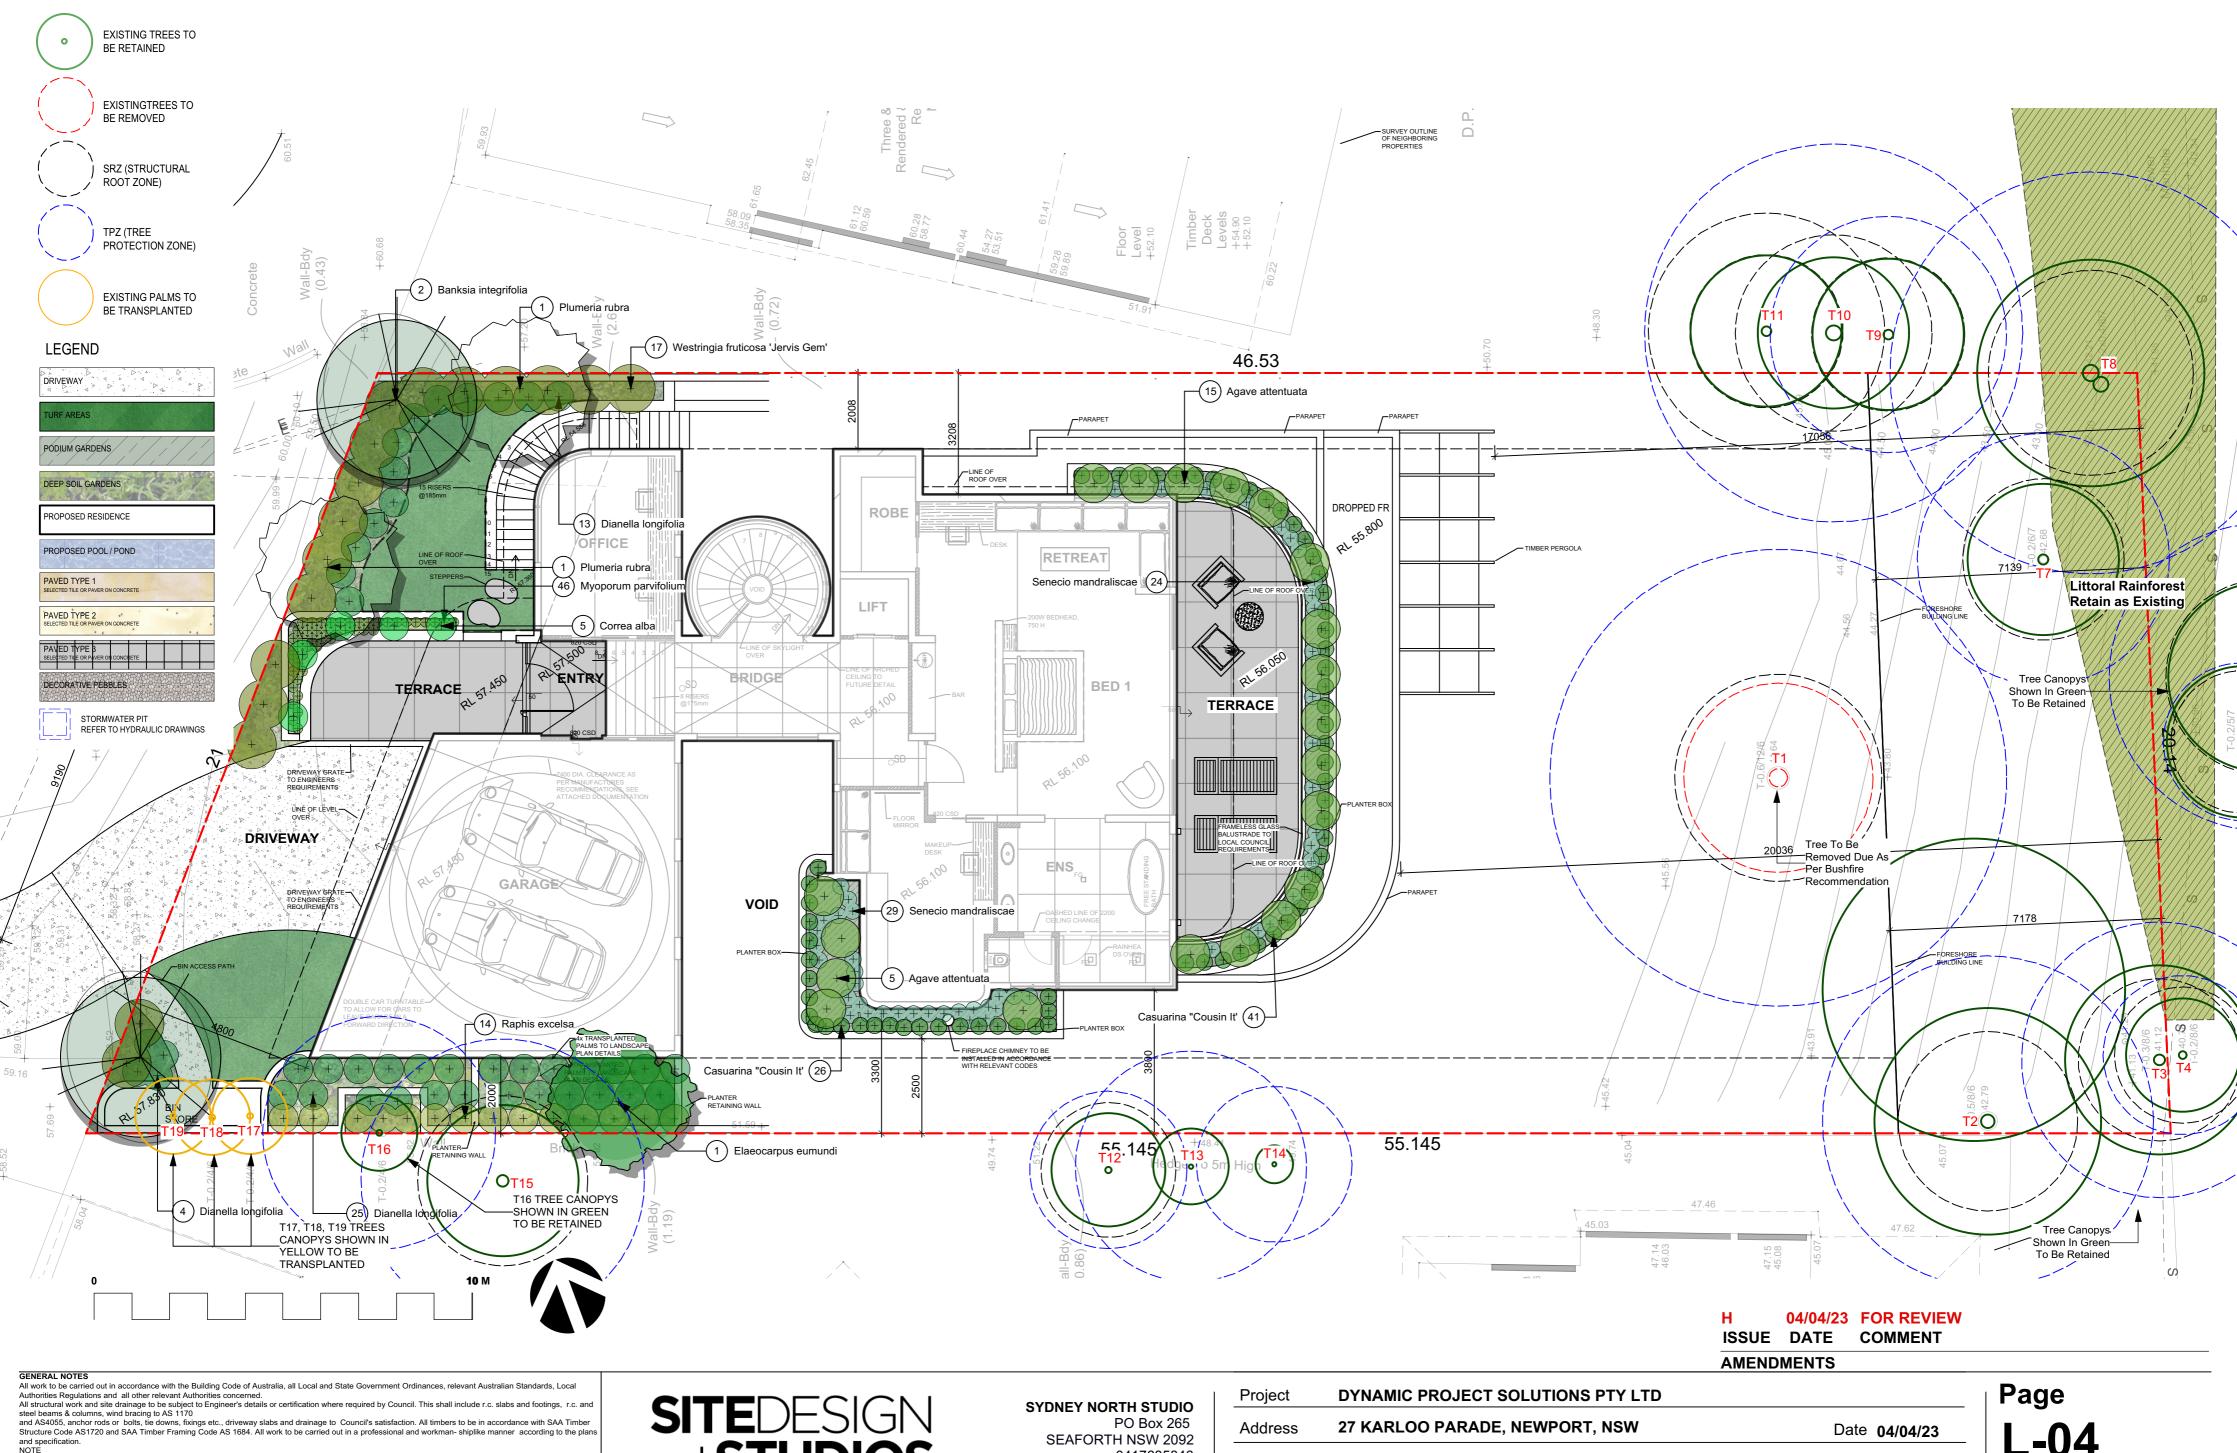
DYNAMIC PROJECT SOLUTIONS PTY LTD Project 27 KARLOO PARADE, NEWPORT, NSW Address Date 04/04/23 Drawing Title SITE PLANS Scale 1:150@A2

Drawing No. **1437**

Page L-01







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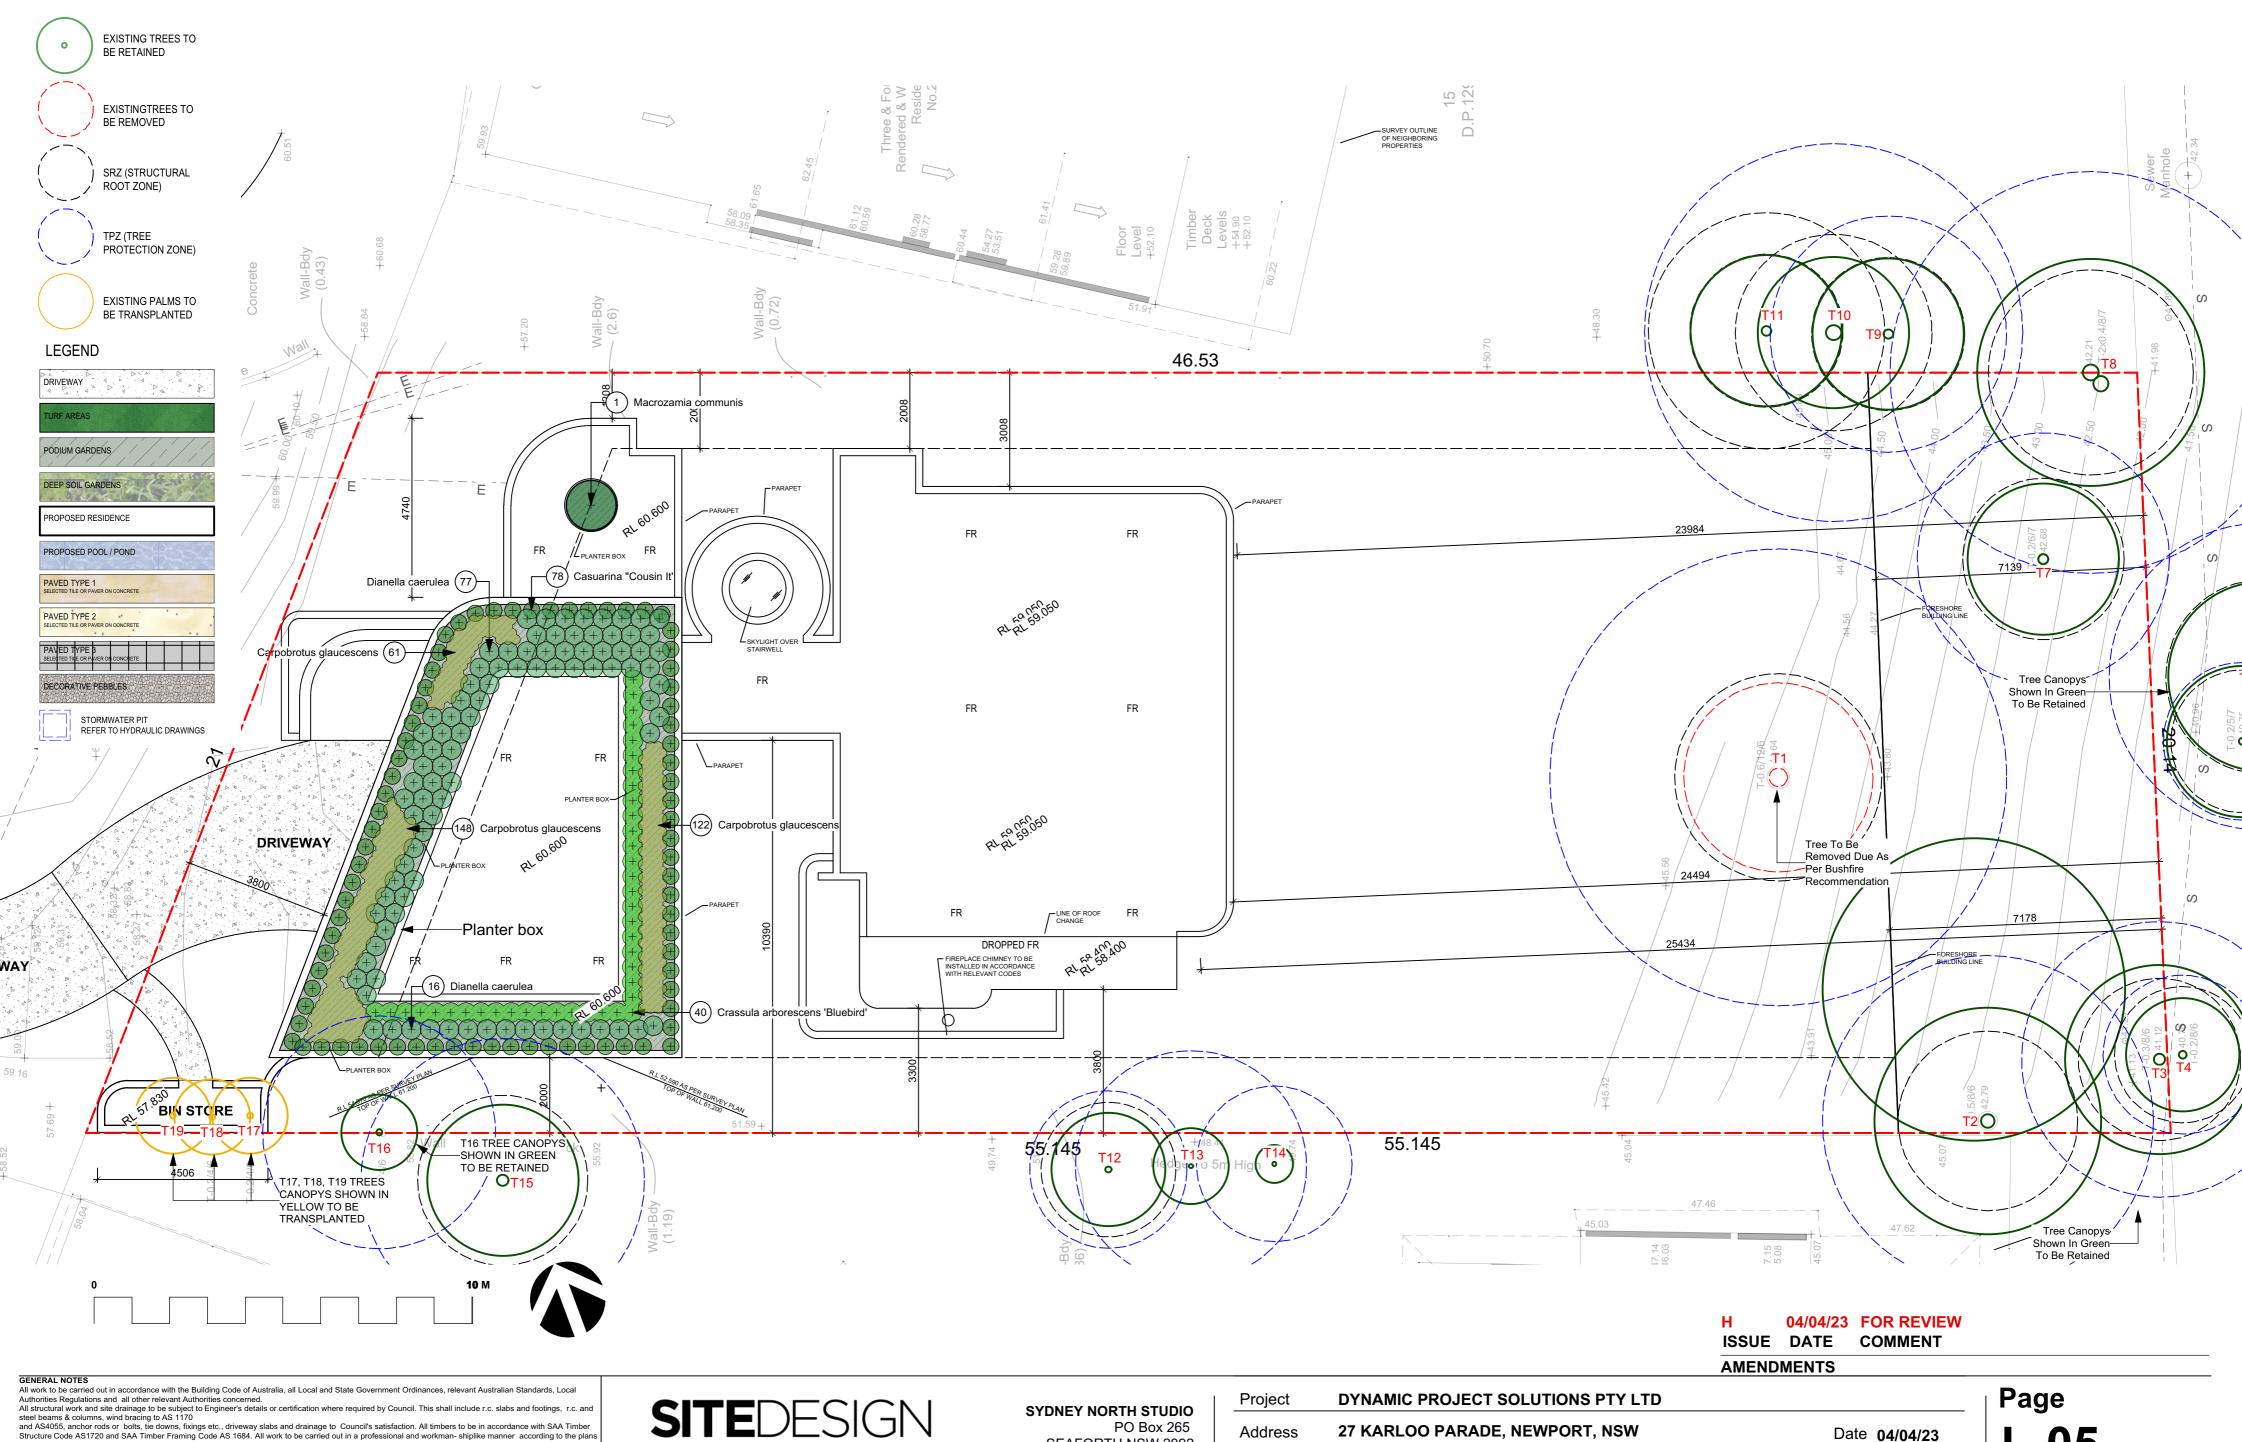
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27 KARLOO PARADE, NEWPORT, NSW Address Date 04/04/23 Drawing Title LEVEL 3 LANDSCAPE PLAN Scale 1:100@A2 Page L-04

Drawing No.1437



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27 KARLOO PARADE, NEWPORT, NSW Address Date 04/04/23 Drawing Title ROOF LANDSCAPE PLAN Scale 1:100@A2 Drawing No.1437

Page L-05

| Plant I | List | | | | | | | | | | | | | |
|----------------------------------|---|---|--|---|--|-----------------------------|---|--|--|--|--|--|--|-----------------|
| ID | Botanical Name | Common Name | Scheduled Size | Mature Height | Mature Spread | Qty | | | | | ATTACK OF | | THE PARTY OF THE P | |
| rees an-int | Banksia integrifolia | Coastal Banksia | 45L | 8m | 3m | 2 | | | | | | | | |
| 11-1111 | Elaeocarpus eumundi | Smoothed leaved Quandong | 45L | 5 - 10m | 2.0 - 3.5m | 1 | 大学 第二十二十二十二十二十二十二十二十二十二十二十二十二十二十二十二十二十二十二十 | | | | | | | |
| - o-fer | Glochidion ferdinandi | Cheese Tree | 45L | 5 - 10m | 6 - 10m | 1 | | | | | | | | |
| edu | Pandanus utilus | Screw Pine | 45L | 5 - 10m | 2.0 - 3.5m | 2 | THE REST WILLIAM | 一种人的 | | | | | | |
| m-rub | Plumeria rubra | Frangipani | 45L | 3 - 5m | 3.5 - 6m | | Banksia integrifolia | Elaeocarpus eumundii | Glochidion ferdinandi | Pandanus utilis | Plumeria rubra | Alpinia zerumbet ' Variegata | a' Banksia ericifolia | Bank |
| rubs | | 01 | | | , | | Coastal Banksia | Eumundi quandong | Cheese tree | Screwpine | Plumeria Tri Colour | | Heath-leaved banksia | Birtl |
| zer'Var | Alpinia zerumbet 'Variegata' | Variegated Shell Ginger | 200mm | 1 - 1.8m | 1.2 m | 27 | | | | | | | | |
| -eri | Banksia ericifolia | Heath-leaved Banksia | 200mm | 3 - 5m | 3.5 - 6m | 3 | | | | | | | | |
| -spi | Banksia spinulosa | Hairpin Banksia | 200mm | 0.9 - 1.5m | 0.9 - 1.2m | 31 | | | | | 第 | | | |
| alb | Correa alba | White Correa | 200mm | 0.9 - 1.5m | 0.9 - 1.2m | 56 | | | | | | | | |
| ef | Correa reflexa | Native Fuchsia | 200mm | 0.9 - 1.5m | 0.9 - 1.2m | | | A CAMPACT | | | | | | |
| lut | Dypsis lutescens | Golden Cane Palm | 300mm | 2-4m | 2-3m | 17 17 | | | | A STATE OF THE STA | | | | |
| tho | Metrosideros excelsa Nandina domestica | New Zealand Christmas Tree Sacreed bamboo | 45L 200mm | 1-2m 0.8 -1m | 1-2m | | Correa alba | Correa reflexa | Dypsis lutescens | Metrosideros excelsa | Nandina domestica | Raphis excelsa | Syzygium Australe-resiliend | e West |
| -do | Raphis excelsa | Lady Palm | 300mm | 3 - 5m | 1m 2.0 - 3.5m | 21 40 | White correa | Native fuchsia | Golden cane palm | New Zealand Christmas tree | Sacreed Bamboo | Lady Palm | Lilly Pilly | Coas |
| exc au're' | Syzygium australe 'Resilience' | Lilly Pilly | 200mm | 3 - 6m | 1.5m | 23 | | | | | | | | |
| -fru | Westringia fruticosa | Coastal Rosemary | 200mm | 0.6m | 0.9m | 10 | 44 A | | | | | | | |
| -fru'JG | Westringia fruticosa 'Jervis Gem' | | 200mm | 1 ~ 1.2 metre | 1 ~ 1.5 metre | 17 | | | | | | | | 4 |
| und Co | | Coustai resolutiy | 20011111 | 1 1.2 mode | 1 1.0 111000 | | | | | | | | | |
| att | Agave attentuata | lion's tail | 150mm | 0.75 - 0.9m | 0.5 - 1.2m | 20 | | | | | | | | |
| nud | Blechnum nudum | Fishbone Water Fern | 150mm | 0.75 - 0.9m | 0.3 - 0.6m | 34 | | | | STATE OF THE STATE | | | | |
| gla | Carpobrotus glaucescens | Coastal Moonflower, Pigface, Iceplant | 150mm | 0.0 - 0.3m | 1.2 - 2.0m | 352 | Western | Annual Marian | Platim | Complyation | | | | 7 |
| ci' | Casuarina "Cousin It' | Casuarina "Cousin It' | 150mm | 0.0 - 0.3m | 1.2 - 2.0m | 145 | Westringia fructicosa 'Jervis Gem Coastal rosemary | n' Agave attentuata Lion's tail | Blechnum nudum Fishbone water fern | Carpobrotus glaucescens Pgs Face | Casuarina 'Cousin it' Cousin it | Crassula arborescens 'Blue Bird' | Hibbertia scandens Golden guinea flower | |
| arb | Crassula arborescens 'Bluebird' | 'Blue Bird' | 150mm | 0.0 - 0.3m | 0.3 - 0.6m | 40 | _ | | | | NAME OF THE OWNER, WHICH SAME OF THE OWNER, WHITE SAME OF THE OWNER, WH | | | |
| sca | Hibbertia scandens | Snake Vine | 150mm | 0.3m | 1.2m | 130 | Sule in | | | | | | | |
| -par | Myoporum parvifolium | Carpet Spreading Myoporum | 150mm | 0.45 - 0.6m | 0.3m | 111 | A STATE OF A | | | | | | | |
| ma | Senecio mandraliscae | Blue Chalk Sticks | 150mm | 0.15m | 0.5m | 53 | 梨油 众 水 4 | | | 7.4 | | THE RESERVE OF THE PERSON IN PARTY AND THE PERSON IN P | | 7 |
| ie | Viola hederacea | Native Violet | 150mm | 0.2m | 0.8m | 23 | THE TOWN ME ME | | 为世代 | 是死行的 | 15000分钟表现 | | | |
| lh' | Westringia 'low horizon' | coastal rosmary | 200mm | 0.4m | 0.8m | 60 | | | 10000000000000000000000000000000000000 | / 建一切的 | | | | |
| ten | Zoysia tenuifolia | Petting Grass | 150mm | 0.0 - 0.3m | 0.3 - 0.6m | 63 | A TO MY | | THE STATE OF THE S | | | | | F . |
| sses cae | Dianella caerulea | Blue Flax-lily | 150mm | 0.4m | 0.6m | 114 | Myoporum parvifolium Yareena Creeping Boobiala | Senecio mandraliscae Blue Chalk Stick | Viola hederacea Native Violet | Westringia low horizon Coastal rosemary | Zoysia tenuifolia Petting grass | Dianella caerulea | Dianella longifolia | |
| on | Dianella longifolia | Blueberry Lily, Blue Flax Lily | 150mm | 0.75 - 0.9m | 0.0 - 0.3m | 42 | . a. cona Oreeping Dooblald | Dide Chalk Stick | realive violet | ooastai ioseiiidi y | r etting grass | Flax Lilly | Blue Flax Lilly | |
| nu | Dianella multiflora | Blue dianella | 150mm | 0.6m | 0.3m | 51 | | | | | | | | |
| rev-lr | Dianella revoluta | Spreading Flax Lily | 150mm | 0.3 - 0.45m | 0.3 - 0.6m | 16 | | | | | | | | |
| u | Liriope muscari | Turf Lily 'Royale Purple' | 150mm | 0.6m | 0.5m | 34 | | | | | | | | |
| ı-lon | Lomandra longifolia | Spiny-headed Mat-Rush | 150mm | 0.6m | 0.8m | 28 | | | | | | | | |
| -ta | Lomandra 'Tanika' | Fine-leaved mat rush | 150mm | 0.5m | 0.6m | 21 | | | | | | | | |
| c-com | Macrozamia communis | Burrawang | 150mm | 1 - 1.5 m | 1 - 1.5 m | 2 | | | | | | | | |
| -aus | Asplenium australasicum | Birds Nest Fern | 150mm | 1m | 1.2m | 34 | Dianella multiflora Blue Dianella | Dianella revoluta Spreading Flax Lilly | <i>Liriope muscari</i> Turf Lily Royale Purple | Lomandra longifolia Mat Rush | Lomandra tanika Fine leafed mat rush | Macrozamia communis Burrawang | Asplenium australasicum Crow's nest fern | |
| | | | atter to the state of the state | | – STAGGERED PATTERN TO DENSITIES AS | | | | | | | | | |
| | | MIN TWO OFF 38 X 38 X 1800MM HIGH POINTED HARDWOOD STAKES | REFER TO THE PARTY OF THE PARTY | \times | SCHEDULE - CONTAINERISED PLANT AS | | | | | SII | R WALTER TURF ROLLS AS SPECIFIED HES 300MM PROUD OF ADJACENT SUP | LAY ROLLS SO THAT TURF RFACES. LIGHTLY COMPACT TO PREVENT SUBSIDENCE. | SPREAD & RAKE MII UNDERLAY SOIL (80 FINISHED LEVELS & | 20 SAND/SOIL MI |
| | | TOINTED HANDWOOD STARES | | | PER PLANTING SCHEDULE | | | PLANTING A | AT | | EDGES | TO PREVENT SUBSIDENCE. | | |
| | | POSITION TIE ABOVE SUITABLE | (\checkmark) | \smile | | | | SPECIFIED DENSITIE | ES | | 1 | <u>0</u> | LIGHT | |
| FERTILISI PLANTING | E G AS | BRANCH CROTCH | PLAN VIEW | | | | | MULCH 50m | m | | | | LIGHTLY RIP SUBGRADE | |
| SPECIFIE | | 50MM WIDE JUTE MESH WEBBING STAPLED TO STAKES | | | | | | | | \\\\\\/\/\\\\\\\\\\\\\\\\\\\\\\\\\\\\\ | \\ /// | TURF DETAIL NTS | | |
| | | | SHRUB REFER TO PLANTING SCHEDU | JLE ^ | | (AS SPECI | PTH MULCH IFIED DISHED | EXTENSIVE MEDIA TO A DEPTH O 200mm. HYDROCELL 40 (SUPLIE) | R: \\\\\ | | | | | |
| 80MM MU AS SPCIF | JLCH SIED | _ | \ \ M | | | TO BASE O | OF TREE) | FYTOGREEN) OR SIMILA | | | | | | |
| au orulf | | — EDGING AS SHOWN ON PLAN | \\\\\\ | |)(AM) | | | DRIP IRRIGATIO | n | | | | | |
| | | PLANTING HOLE | | | |) | | | 14////// | FA/L 1:100 | N N N N N N N N N N N N N N N N N N N | | | |
| | | COMPACTED TOD CO. | | ~///////////////////////////////////// | | | | WATER RESERVOIR 45m | | | ///// 8 | | | |
| | | COMPACTED TOP SOIL | | 11,111111111111111111111111111111111111 | | | MM IMPORTED FOR SHRUBS | HYDROCELL RG30 (SUPLIEI FYTOGREEN) OR SIMILA | | <u></u> | PRO | TECTION BOARD | | |
| <u> </u> | | CIII TIVATE CUB BACE WITH COROURS AS | $\sqrt{}$ | $\wedge \wedge \wedge \wedge \wedge$ | $\ \ \ \ \ \ \ \ \ \ \ \ \ \ \ \ \ \ \ $ | BACKFILL CONSOLID | ATE | GEOFABRI | | | wat | ERPROOFING MEMBRANE | | |
| Γ / | | CULTIVATE SUB BASE WITH GYPSUM AS SPECIFIED IN CLAY SOILS | <u>/ / / </u> | | <u> </u> | WITH MIN 5 IMPROVED | 50MM DEPTH O SITE SOIL | BIDIM A14 OR SIMILA DRAINAGE CEL | | | CON | CRETE SLAB | | |
| | | | | | | AS SPECIF | TEU | | I | | PRO | VIDE 1:100 FALL | | |
| | 600 | EXISTI | NG SUBGRADE | | T | | | | | | | DRAINAGE | | |
| | 1000 X 1000 MULCH | | 46444 | L SHRUB PLANTIN | «.«.«.«.«.«.«.«.«.«.».«.».«.».«.».«.».« | BREAK UP CULTIVATE SUBGRADE | E | | TYPICAL P | LANTING/ PODIUM DETAIL | н | 04/04/23 FOR R | EVIEW | |
| | TYPICAL TREE PLANTING NTS | DETAIL | NTS | L GIINOB FLANTIN | <u>O DETAIL</u> | 150MM DEF | | | | | ISS AMI | | | |
| | ordance with the Building Code of Australia, all Loca other relevant Authorities concerned. | al and State Government Ordinances, relevant Australian S | | | | | | Project | | ROJECT SOLUTIONS P | | | Page | |
| ind site draina mns, wind bra | age to be subject to Engineer's details or certification racing to AS 1170 | on where required by Council. This shall include r.c. slabs at | nd footings, r.c. and | SITE |)ESIGI | \setminus | SYDNEY NORTH | H STUDIO | | | | | | _ |
| | | nage to Council's satisfaction. All timbers to be in accordant arried out in a professional and workman- shiplike manner a | occording to the plans | | | | PC SEAFORTH N | D Box 265 NSW 2092 Addres | ss 27 KARLOO | PARADE, NEWPORT, N | ISW | Date 04/0 4 | 4/23 L-0 | 6 |
| | nless otherwise stated and use figured dimensions i | in preference. f any work, all dimensions and levels are subject to final sun | vev and set-out | +ST | UDIO | S | 04 | 147005040 | g Title PLANTIN | IG DETAILS | | Scale N.T. | S@A2 L-U | J |
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Scale N.T.S@A2 Drawing Title **PLANTING DETAILS**

Drawing No.1437



POOL COMPLIANCE NOTES

The design of the swimming pool and associated equipment must comply with the following requirements:

i) The Swimming Pools Act & Regulations.

ii) Australian Standard 1926 Swimming Pool Safety as prescribed under the

Building Code of Australia.

iii) The pump and associated equipment must be sound insulated and/or isolated so

that the noise emitted does not exceed an LAeq (15min) of not more than 5 dB(A) above the background level in any octave band from 31.5Hz to 8KHz centre frequencies inclusive at the boundary of the site

The swimming pool excavation and/or swimming pool must be provided with a suitable barrier to prevent a risk of falling into the excavation or pool at all times throughout the construction phase.

- -The measurement of sound must be carried out in accordance with Australian
- Standard 1055.1.
- -Landscaping and ancillary structures must not intrude into the child-resistant

barrier Non-Climbable Zone.

- -Only structures associated with the pool may be located within the pool area.
- -Clothes lines, barbeque, sheds, entertainment structure, outside toilets or any other non pool-related structures are not permitted within the pool area.

Before the issue of any Occupation Certificate;

- i) The child resistant barrier must be installed in accordance with A above.
- ii) The swimming pool is to be registered in the NSW Swimming Pool Register.

The pump and associated equipment must be maintained and operated in accordance with the noise levels described above.

ii) The child resistant barrier must be maintained in accordance with the Australian Standard as described above.

LANDSCAPE MAINTENANCE NOTES

| MONTH | MOWING EDGING BLOWING | FERTILISING (SEASOL) | CHECK | HAND WEED REMOVAL | PRUNING | WEED SPARAYING | WATERING/ IRRIGATION | PLANT REPLACEMENT IF REQUIRED |
|-------|-----------------------------|-------------------------|-------|-------------------------|---------|-------------------|-------------------------|-------------------------------|
| DEC | W | M | М | W | F | М | D | W |
| JAN | W | М | М | W | F | М | D | W |
| FEB | W | М | М | W | F | М | D | W |
| MAR | F | М | М | F | М | М | D | W |
| APR | F | N/A | М | F | М | М | D | W |
| MAY | F | N/A | М | М | М | М | D | W |
| JUNE | M | N/A | М | M | N/A | N/A | 2ND D | W |
| JULY | М | N/A | М | M | N/A | N/A | 2ND D | W |
| AUG | M | N/A | М | M | N/A | N/A | 2ND D | W |
| SEP | М | М | М | М | N/A | N/A | 2ND D | W |
| ОСТ | F | F | М | F | М | М | D | W |
| NOV | F | F | М | F | М | М | D | W |

KEY D-DAILY, W-WEEKLY, F-FORTNIGHT, M-MONTHLY, 2ND DAY,

PLAN NOTES

This plan should be read in conjunction with the architectural and hydraulics plans. Work specific to these plans should be prepared in accordance to these plans, including specification and details prior to the installation of landscaping, and should not be altered or compromised during landscape construction.

Retaining wall details to engineers design.

Authorities Regulations and all other relevant Authorities concerned

and specification.

Elements such as drainage swales may be incorporated in garden bed areas (using non-floatable mulch) without compromising the capacity or form.

The Design & location of new letter boxes shall be in accordance with Australia Post's "Requirements for Delivery of Mail to Residential Premises" published Feb '97. All noxious weeds listed in Councils weed lists & located on the site shall be continually removed & suppressed. Reinstate all boundary fencing in poor condition with Council approved 1.8m fencing to rear of building line, rake to 1m forward of BL. Pollution, sediment & erosion control devices as specified shall be in place, and maintained for the duration of the construction period. Proposed excavation near existing established trees to be supervised by arborist.

This plan has been prepared for DA approval only, not for construction.

Planting proposed using commercially available plant species selected from local planting lists and the BASIX local plant lis

D.A approved landscape plan's are required to be constructed as approved to obtain occupancy certificate.

All work to be carried out in accordance with the Building Code of Australia, all Local and State Government Ordinances, relevant Australian Standards, Local

All structural work and site drainage to be subject to Engineer's details or certification where required by Council. This shall include r.c. slabs and footings, r.c. and steel beams & columns, wind bracing to AS 1170

and AS4055, anchor rods or bolts, tie downs, fixings etc., driveway slabs and drainage to Council's satisfaction. All timbers to be in accordance with SAA Timber

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IRRIGATION NOTE

NOTE

ALL GARDENS TO HAVE INSTALLED A DRIP IRRIGATION SYSTEM CONTROLLED FROM WITHIN THE STORE AND RUN OF TANK WATER (POSSIBLE TOWN WATER TOP UP). IRRIGATION SYSTEM CAN BE DESIGNED AND INSTALLED BY SITEDESIGN + IRRIGATION CALL DAVID JAMES +61 488 358 180

MAINTENANCE GENERAL NOTES

SECTION C: LANDSCAPE MAINTENANCE SPECIFICATION 1.0 SCOPE

The 52 week Planting Establishment Period commences at the date of registration of the repective plan. The contractor is to also allow for maintenance from the date of Practical Completion to the start date of the 52 week Planting Establishment Period. The allowance shall be for a weekly rate which will then be implemented until the formal maintenance period commences.

1.2 PROGRAM

Furnish a proposed planting maintenance program with the tender.

1.3 MAINTENANCE LOGBOOK

Contractor to keep a maintenance record of works carried out on a monthly basis. Log should include but not limited to: - Activities carried out during each attendance;

- Irregularities encountered and actions taken:

NB: Maintenance payments will be evaluated on submission of monthly logbooks.

1.4 RECURRENT WORKS

Throughout the Planting Establishment Period, continue to carry out recurrent works of a maintenance nature including, but not limited to, watering, mowing, weeding, rubbish removal, fertilising, pest and disease control, staking and tying, replanting, cultivating, pruning and keeping the site neat and tidy. All rubbish related to

landscape works shall be removed by the landscape contractor before it is allowed to accumulate. 1.5 PLANTING

Commence recurrent planting maintenance works at the completion of planting. Ensure the stock arriving on site is protected and maintained for healthy growth.

1.6 REPLACEMENTS

Continue to replace failed, damaged or stolen plants for the extent of the Planting Establishment Period.

1.7 MULCHED SURFACES

Maintain the surface in a clean and tidy condition and reinstate the mulch as necessary.

1.8 GRASSED AREAS

Commence grass maintenance works at the completion of turfing, and continue to carry out grass maintenance throughout the contract and Planting Establishment Period, maintaining healthy weed free growth.

1.9 STAKES AND TIES

Adjust or replace as required. Remove those not required at the end of the Planting Establishment Period.

1.10 WATERING/ IRRIGATION

An irrigation system is to be installed to all mass planted beds and new tree planting, connected to a pump and the rainwater tank /OSD tank. Install one tap near the front boundary (Wurrook Circuit) and one tap on the rear (eastern) boundary. This system shall be installed and maintained for the duration of the maintenance period (52 weeks) and in perpetuity of the development. All irrigation works shall be performed by a licensed irrigation contractor. Materials to be used are to be submitted to the site superintendent for approval. The contractor shall provide design drawings and material specifications/samples prior to commencing work. All works are to be conducted to all current and relevant Australian Standards.

The contractor is to be completely responsible for the coordination of the installation of the irrigation system with other services throughout the site. Recommended flow rates: The system shall be set up on a trial basis and them adjusted to suit the local requirements and conditions. Once the system is satisfactorily adjusted the contractor shall make fortnightly visits within the establishment period to ensure satisfactory performance of the system and to adjust the watering periods as required. A minimum even coverage of 25mm of water per week is recommended.

2.0 REPORTS

2.1 LANDSCAPE MAINTENANCE REPORT

'Landscape Maintenance Reports' shall be submitted to the Principle Certifying Authority by the contractor verifying that satisfactory maintenance of the landscape works has been undertaken and that any necessary rectification measures have been carried out to a high professional standard. This documentation is to be submitted through the plant establishment period.

04/04/23 FOR REVIEW ISSUE DATE COMMENT

Page

L-07

AMENDMENTS

DYNAMIC PROJECT SOLUTIONS PTY LTD

27 KARLOO PARADE, NEWPORT, NSW

Date 04/04/23

Scale N.T.S@A2

Drawing No.1437

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Project

Address

Drawing Title **NOTES**

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LANDSCAPE WORK SPECIFICATION

PRELIMINARIES

1.01 GENERAL

The following general conditions should be considered prior to the commencement of landscape works:

The landscape plans should be read in conjunction with the architectural plans, hydraulic plans, service plans and survey prepared for the proposed

All services including existing drainage should be accurately located prior to the commencement of landscape installation. Any proposed tree planting which falls close to services will be relocated on site under the instruction of the landscape architect.

Installation of conduit for required irrigation, electrical and other services shall be completed prior to the commencement of hardscape works and

hardstand pours.

All outdoor lighting specified by architect or client to be installed by qualified electrician

Anomalies that occur in these plans should be brought to our immediate attention.

Where an Australian Standard applies for any landscape material testing or installation technique, that

standard shall be followed

1.02 PROTECTION OF ADJACENT FINISHES

The Contractor shall take all precautions to prevent damage to all or any adjacent finishes by providing adequate protection to these areas / surfaces prior to the commencement of the Works

1.03 PROTECTION OF EXISTING TREES

Existing trees identified to be retained shall be done so in accordance with NATSPEC Guide 2 "A Guide to Assessing Tree Quality". Where general works are occurring around such trees, or pruning is required, a qualified Arborist shall be engaged to oversee such works and manage tree health

Existing trees designated on the drawing for retention shall be protected at all times during the construction period. Any soil within the drip-line of existing

trees shall be excavated and removed by hand only. No stockpiling shall occur within the root zone of existing trees to be retained.

Any roots larger in diameter than 50mm shall only be severed under instruction by a qualified arborist. Roots smaller than 50mm diameter shall be cut

Temporary fencing shall be installed around the base of all trees to be retained prior to the commencement of landscape works. Where possible this fencing

will be located around the drip line of these trees, or a minimum of 3m from the trunk. The fencing shall be maintained for the full construction period. 1.04 EROSION & POLLUTION CONTROL

The Contractor shall take all proper precautions to prevent the erosion of soil from the subject site. The contractor shall install erosion & sediment control barriers and as required by council, and maintain these barriers throughout the construction period. Note that the sediment control measures adopted

should reflect the soil type and erosion characteristics of the site Erosion & pollution control measures shall incorporate the following:

- Construction of a sediment trap at the vehicle access point to the subject site.
- Sediment fencing using a geotextile filter fabric in the location indicated on the erosion control plan or as instructed on

site by the landscape architect.

- Earth banks to prevent scour of stockpiles
- Sandbag kerb sediment traps
- Straw bale & geotextile sediment filter.
- Exposed banks shall be pegged with an approved Jute matting in preparation for mass planting

Refer to "Sitewise Reference Kit" as prepared by DLWC & WSROC (1997) for construction techniques

SOIL WORKS

2.01 MATERIALS

Specified Soil Conditioner (Generally to improve site soil)

The specified soil conditioner for site top-soil improvement shall be an organic mix, equal to "Botany Humus", as supplied by ANL. Note that for sites where soil testing indicates toxins or extremes in pH, or soils that are extremely poor, allow to excavate and supply 300mm of imported soil mix.

New gardens & proposed Planting

New garden and planting areas shall consist of a 50/50 mix of clean site soil (refer d) below) and imported "Organic Garden Mix" as supplied by ANL or approved equal. All mixes are to comply with AS 4419 Soils for landscaping & garden use, & AS 4454 Composts, Soil conditioners & mulches. Specified Soil Mix - Turf

The specified soil mix for all turf areas shall be a min 75mm layer of imported soil mix consisting of 80% washed river sand (reasonably coarse), and 20% composted organic matter equivalent to mushroom compost or soil conditioner, or other approved lawn top dress.

Site topsoil is to be clean and free of unwanted matter such as gravel, cXXlay lumps, grass, weeds, tree roots, sticks, rubbish and plastics, and any deleterious materials and materials toxic to plants. The topsoil must have a pH of between 5.5 and 7. Use 100% imported soil mix when site when site topsoil runs out.

2.02 INSTALLATION

Subgrade levels are defined as the finished base levels prior to the placement of the specified material (i.e. soil conditioner). The following subgrade levels

shall apply:

Mass Planting Beds - 300mm below existing levels with specified imported soil mix.

permission or accepted work practices resulting in inferior construction. Locate and protect all services prior to construction.

All work to be carried out in accordance with the Building Code of Australia, all Local and State Government Ordinances, relevant Australian Standards, Local

All structural work and site drainage to be subject to Engineer's details or certification where required by Council. This shall include r.c. slabs and footings, r.c. and steel beams & columns, wind bracing to AS 1170

and AS4055, anchor rods or bolts, tie downs, fixings etc., driveway slabs and drainage to Council's satisfaction. All timbers to be in accordance with SAA Timber

Structure Code AS1720 and SAA Timber Framing Code AS 1684. All work to be carried out in a professional and workman- shiplike manner according to the plans

Do not scale off the drawings unless otherwise stated and use figured dimensions in preference.

All dimensions are to be checked and verified on site before the commencement of any work, all dimensions and levels are subject to final survey and set-out

No responsibility will be accepted by Sitedesign for any variations in design, builder's method of construction or materials used, deviation from specification without

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Turf areas - 100mm below finished surface level.

Authorities Regulations and all other relevant Authorities conce

Note that all subgrades shall consist of a relatively free draining natural material, consisting of site topsoil placed previously by the Civil Contractor. No builders waste material shall be acceptable.

b) Subgrade Cultivation

c) Drainage Works

Cultivate all subgrades to a minimum depth of 100mm in all planting beds and all turf areas, ensuring a thorough breakup of the subgrade into a reasonably coarse tilth. Grade subgrades to provide falls to surface and subsurface drains, prior to the placement of the final specified soil mix.

Install surface and subsurface drainage where required and as detailed on the drawing. Drain subsurface drains to outlets provided, with a minimum fall of 1:100 to outlets and / or service pits.

d) Placement and Preparation of Specified Soil Conditioner & Mixes.

Trees in turf & beds - Holes shall be twice as wide as root ball and minimum 100mm deeper - backfill hole with 50/50 mix of clean site soil and imported "Organic Garden Mix" as supplied by ANL or approved equal.

Mass Planting Beds - Install specified soil conditioner to a compacted depth of 100mm

Turf Areas - Install specified soil mix to a minimum compacted depth of 75mm.

Place the specified soil conditioner to the required compacted depth and use a rotary hoe to thoroughly mix the conditioner into the top 300mm of garden bed soil. Ensure thorough mixing and the preparation of a reasonably fine tilth and good growing medium in preparation for planting.

Place the specified soil mix to the required compacted depth and grade to required finished soil levels, in preparation for planting and turfing.

PLANTING

3.01 MATERIALS

a) Quality and Size of Plant Material

All trees supplied above a 25L container size must be grown and planted in accordance with Clarke, R 1996 Purchasing Landscape Trees: A guide to assessing tree quality. Natspec Guide No. 2. Certification that trees have been grown to Natspec guidelines is to be provided upon request of Council's Tree Management Officer.

Above - Ground Assessment:

The following plant quality assessment criteria should be followed:

Plant true to type, Good vigour and health, free from pest & disease, free from injury, self-supporting, good stem taper, has been pruned correctly, is apically dominant, has even crown symmetry, free from included bark & stem junctions, even trunk position in pot, good stem structure Below - Ground Assessment:

Good root division & direction, rootball occupancy, rootball depth, height of crown, non-suckering For further explanation and description of these assessment criteria, refer to Ross Clark's book.

All Plant material shall be to the type and size specified. No substitutions of plant material shall be permitted without written prior approval by the Landscape Architect, No plant shall be accepted which does not conform to the standards listed above

b) Stakes and Ties

Provide min. 2 No. Stakes and ties to all plants identified as trees in the plant schedule. Stakes shall be sound, unpainted, straight hardwood, free of knots and pointed at one end. They shall be 2200mm x 50mm x 50mm Hardwood, or approved alternative. Ties shall be 50mm wide bessian webbing material.

c) Fertilisers

Fertilisers shall be approved slow release fertilisers suitable for the proposed planting types. Note that for native plants, specifically Proteaceae family plants including Grevillea species, low phosphorus fertilizers shall be used.

d) Mulch

Mulch shall be an approved equal to "Forest Blend" as supplied by ANL. Mulch shall be completely free from any soil, weeds, rubbish or other debris.

Turf shall be "Sir Walter" Buffalo or equivalent (unless stated otherwise), free from any weeds and other grasses, and be in a healthy growing condition.

3.02 INSTALLATION

a) Setting Out

All planting set out shall be in strict accordance with the drawings, or as directed. Note that proposed tree planting located near services should be adjusted at this stage. Notify Landscape Architect for inspection for approval prior to planting.

b) Planting

All plant material shall be planted as soon after delivery as possible. Planting holes for trees shall be excavated as detailed and specified. Plant containers shall be removed and discarded, and the outer roots gently teased from the soil mass. Immediately set plant in hole and backfill with specified soil mix, incorporating the approved quantity of fertiliser for each plant type. Ensure that plants are set plumb vertically and root balls set to the consolidated finished grades detailed on the drawings. Compact the backfilled soil and saturate by hand watering to expel any remaining air pockets immediately after planting.

c) Staking and Tying

Staking and tying shall be in strict accordance with the drawings and shall occur immediately following plant placement and soil backfilling. All plants identified as "Trees" on the planting schedule shall be staked with a min. 3 stakes.

d) Mulchina

Mulch should be spread so that a compacted thickness of 75mm is achieved after settlement in all planting beds and around each individual plant. Apply immediately following planting and watering in, ensuring that a 50mm radius is maintained around the trunk of each plant . There shall be no mixing of soil and mulch material.

e) Turfing

Moisten soil prior to the turf being laid. Turf shall be neatly butt jointed and true to grade to finish flush with adjacent surfaces. Incorporate a lawn fertilizer and thoroughly water in. Keep turf moist until roots have taken and sods/rolls cannot be lifted. Keep all traffic off turf until this has occurred. Allow for top dressing of all turf areas. All turf shall be rolled immediately following installation

f) Steel Garden Edging

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The Contractor shall install stone edging as shown on the drawings, to all mass planting beds adjoining turf or gravel mulched areas, and where required. The resultant edge shall be true to line and flush with adjacent surfaces.

HARDSCAPE WORKS

4.01 GENERAL

The Contractor shall undertake the installation of all hardscape works as detailed on the drawing, or where not detailed, by manufacturers specification.

Paving - refer to typical details provided, and applicable Australian Standards. Permeable paving may be used as a suitable means of satisfying Council permeable surface requirements, while providing a useable, hardwearing, practical surface. In most instances, the client shall nominate the appropriate paving material to be used.

Australian Standards shall be adhered to in relation to all concrete, masonry & metal work. Some details are typical and may vary on site. All hardscape works shall be setout as per the drawings, and inspected and approved by the Landscape Architect prior to installation. All workmanship shall be of the highest standard. Any queries or problems that arise from hardscape variations should be bought to the attention of the Landscape Architect

Your attention is directed to any obligations or responsibilities under the Dividing Fences Act, 1991 in respect of adjoining property owner/s which may arise from this application. Any enquiries in this regard may be made to the Crown Lands Division on (02) 8836 5332

IRRIGATION WORKS

5.01 GENERAL (PERFORMANCE SPECIFICATION)

An automated drip-irrigation system is to be installed to all gardens, planters and lawn areas in accordance with the approved Irrigation Design.

This system shall be designed and installed by a qualified and licensed irrigation specialist, to the highest industry standards and to maximise the efficient usage of

The Installer is required to obtain all approvals necessary for the completion of works in accordance with the Laws of Australia, Laws of the State of NSW, Council By-Laws and Ordinances.

Drawings

- The Landscape Contractor nominated Licensed Irrigation Specialist shall provide irrigation drawings for approval upon engagement.

- The irrigation system shall be installed prior to all planting works. It shall incorporate a commercially available irrigation system, with sub-surface dripper lines to irrigate all gardens, planters and lawn areas.
- It shall incorporate a suitable back flow prevention device for the scale of works, an in-line filter, check valves, and suitable high and low density poly hose fittings and PVC piping to achieve flow rates suitable for specified planting.
- The irrigation application rate shall not exceed the infiltration rate of the soil or creates run-off.
- The landscape contractor shall check the existing pressure available from the ring mains and size irrigation piping to suit. Supply shall be from local hose cock where available.
- All piping and fittings shall be buried 50mm below the finished soil levels in garden and lawn areas, and secured in position at 500mm centres with galv wire pins.
- Size of pipes shall be selected to ensure the working pressure at the end of the line does not decrease by more than 5%.

Services Co-ordination:

- Co-ordination required by Landscape Contractor or Project Manager to provide required conduit, pipe work and penetration through slabs and planter walls for water
- The Landscape Contractor shall be engaged with the Irrigation Specialist to co-ordinate with the Project Manager to identify the preferred service and conduit locations.
- Project Manager and Landscape Contractor to establish area suitable for irrigation control system with required area, power provision and water supply.

Testing & Defects:

Upon completion of installation, the system shall be tested, including:

- Main Line Pressure Test: The main line is pressurised to test for leaks. All valves are shut and the pressure is taken over a determined length of time.
- Dripper Pressure Test: Measurement at flushing valves are taken and the pressure gauged to make sure it conforms to the manufacturer recommendations. The inlet pressure is then tested under the same conditions to check it does not exceed 300Kpa.
- All components are to be satisfactorily functional and operational prior to approval. Should any defect develop, or the capacity or efficiency of the system decline during the agreed maintenance system, then these faults shall be immediately rectified.

Warranty

- A full 12 month warranty shall be included to cover labour and all parts.

- On request, a detailed irrigation performance specification report can be issued.

times, as well as rectifying any defects that become apparent in the contracted works.

12 MONTH MAINTENANCE

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The consolidation and maintenance period shall be 12 months beginning from the approved completion of the specified construction work (Practical Completion). A qualified landscape maintenance contractor shall undertake the required landscape maintenance works. Consolidation and maintenance shall mean the care and maintenance of Contracted works by accepted landscaping or horticultural practices, ensuring that all plants are in optimum growing conditions and appearance at all

This shall include, but not be limited to, the following items where and as required: Watering all planting and lawn areas / irrigation maintenance.

Clearing litter and other debris from landscaped areas.

Removing weeds, pruning and general plant maintenance

Replacement of damaged, stolen or unhealthy plants. Make good areas of soil subsidence or erosion

Topping up of mulched areas

Spray / treatment for Insect and disease control. Fertilizing with approved fertilizers at correct rates.

Mowing lawns & trimming edges each 14 days in summer or 18 days in winter Adjusting ties to Stakes

Maintenance of all paving, retaining and hardscape elements

On the completion of the maintenance period, the landscape works shall be inspected and at the satisfaction of the superintendent or landscape architect, the responsibility will be signed over to the client.xx

> 04/04/23 FOR REVIEW ISSUE DATE COMMENT

AMENDMENTS

Page L-08

Date 04/04/23

Scale N.T.S@A2

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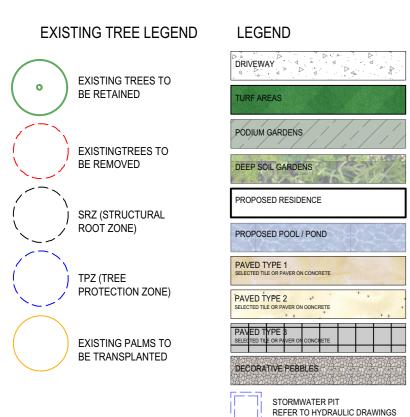
27 KARLOO PARADE, NEWPORT, NSW Address Drawing Title **SPECIFICATION**


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GENERAL NOTES

All work to be carried out in accordance with the Building Code of Australia, all Local and State Government Ordinances, relevant Australian Standards, Local Authorities Regulations and all other relevant Authorities concerned.

All structural work and site drainage to be subject to Engineer's details or certification where required by Council. This shall include r.c. slabs and footings, r.c. and steel beams & columns, wind bracing to AS 1170 and AS4055, anchor rods or bolts, tie downs, fixings etc., driveway slabs and drainage to Council's satisfaction. All timbers to be in accordance with SAA Timber Structure Code AS1720 and SAA Timber Framing Code AS 1684. All work to be carried out in a professional and workman-shiplike manner according to the plans and specification.

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Project DYNAMIC PROJECT SOLUTIONS PTY LTD 27 KARLOO PARADE, NEWPORT, NSW Address Date 04/04/23 Drawing Title ENLARGE LANDSCAPE PLAN Scale 1:50@A2 LEVEL 1 Drawing No.1437

Page L-09

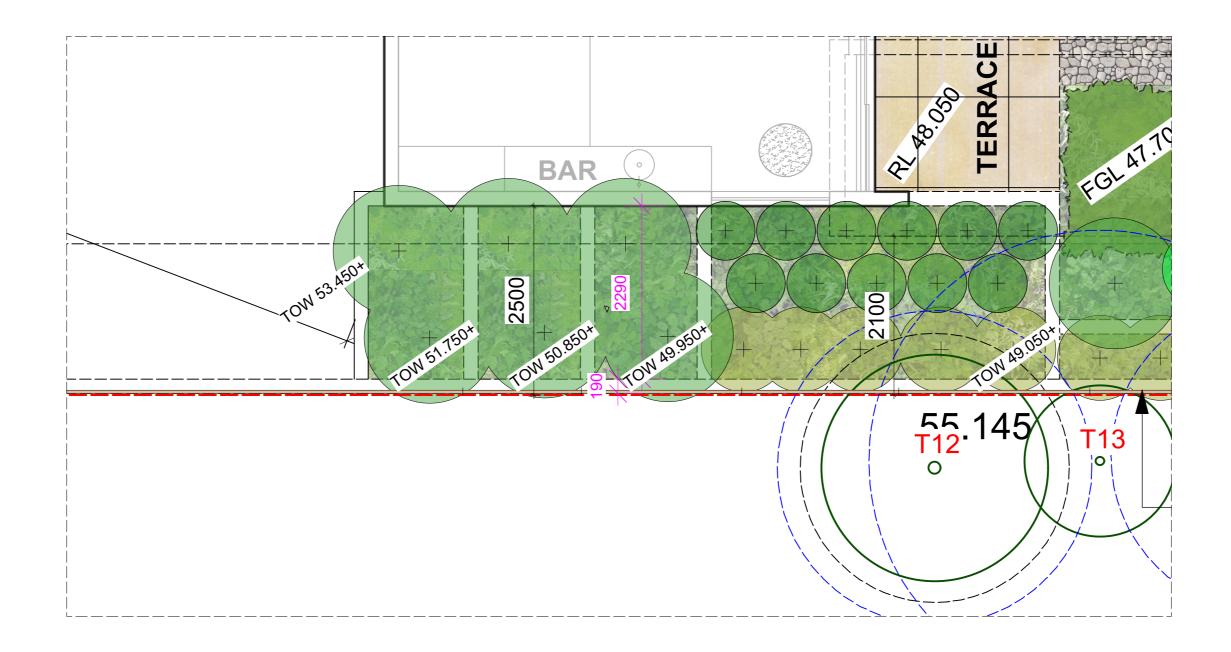04/04/23 FOR REVIEW

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AMENDMENTS